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 a r c h i t e c t s
 a professional corporation

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REVISÉ:

PROJECT NUMBER

0707

DATE _____

JUNE 7, 200

DRAWN BY

L. RASMUSSEN

PROJECT:

OGDEN WEBER ATC
CHILDREN SCHOOL NORTH &
SOUTH BUILDING REROOF

PROJECT ADDRESS:

200 NORTH WASHINGTON BLVD.
OGDEN, UTAH 84404

SHEET TITLE:

TITLE SHEET

SHEET NO

O

OGDEN WEBER ATC CHILDREN SCHOOL NORTH & SOUTH BUILDING REROOFS

200 NORTH
WASHINGTON BLVD.
OGDEN, UTAH 84404

ARCHITECTS

RICHARDS ♦ BOTT ARCHITECTS

620 24TH STREET, OGDEN, UTAH 84401 PHONE (801) 394-3033 FAX (801) 394-9064

SET #

•

•

AB

ACT

ADJ

AFF

ALUM

BD

BLDG

BM

BOT

BRG

BUR

CAB

CJT

CLG

CMU

COL

CONC

CONSTR

CONSTR JT

CONT

CONTR

CORR

CT

DET

DIM

DN

DR

EA

EB

EIPS

EXP JT

ELEC

ELEV

EQ

EQUIP

ENC

EXIST

EXT

FD

FDN

FEQB

FIN

FL

FT

FTG

FUR

AT

ANCHOR BOLT

ACOUSTICAL TILE

ADJUSTABLE

ABOVE FINISH FLOOR

ALUMINUM

BOARD

BUILDING

BEAM

BOTTOM

BEARING

BUILT UP ROOFING

CABINET

CONTROL JOINT

CENTER LINE

CEILING

CONCRETE MASONRY UNITS

COLUMN

CONCRETE

CONSTRUCTION

CONSTRUCTION JOINT

CONTINUOUS

CONTRACT(OR)

CORRIDOR

CERAMIC TILE

DETAIL

DIMENSION

DOWN

DOOR

EACH

EXPANSION BOLT

EXTERIOR INSUL FIN SYSTEM

EXPANSION JOINT

ELECTRICAL

ELEVATION

EQUAL

EQUIPMENT

ELEC WATER COOLER

EXISTING

EXTERIOR

FLOOR DRAIN

FOUNDATION

FIRE EXTINGUISHER CAB

FINISH(ED)

FLOOR

FOOT OR FEET

FOOTING

FURRING

GA

GALV

GC

GL

GYP BD

HC

HDWD

HDWR

HDRL

HM

INSIDE DIAMETER

INCL

INSUL

INTERIOR

JOINT

MAX

MECH

MTL

MFR

MIN

NOT IN CONTRACT

NTS

NOT TO SCALE

ON CENTER

OC

PLATE

PROPERTY LINE

PLASTIC LAMINATE

PLYWOOD

RB

REIN

REIN

RFRG

RH

SC

SCH

SEC

SH

SPEC

SQ

STL

TEMP GL

TYP

VGT

W/

WD

W/O

W/SCOT

GAUGE

GALVANIZED

GENERAL CONTRACTOR

GLASS

GYPSTUM BOARD

HOLLOW CORE

HARDWOOD

HARDWARE

HANDRAIL

HOLLOW METAL

INSIDE DIAMETER

INCLUDE(D/ING)

INSULATION

INTERIOR

JOINT

MAXIMUM

MECHANICAL

METAL

MANUFACTURER

MINIMUM

NOT IN CONTRACT

NOT TO SCALE

ON CENTER

PLATE

PROPERTY LINE

PLASTIC LAMINATE

PLYWOOD

REINFORCE(D/ING)

ROOFING

ROOM

SCHEDULE

SECTION

SIMILAR

SPECIFICATION

SQUARE

STEEL

TEMPERED GLASS

TYPICAL

VINYL COMPOSITION TILE

WITH

WOOD

WINDOW

WITHOUT

WAINSCOT

SECTION

SECTION IDENTIFICATION

SHEET WHERE SECTION IS DRAWN

DETAIL

DETAIL IDENTIFICATION

SHEET WHERE DETAIL IS DRAWN

INTERIOR ELEVATIONS

ELEVATION IDENTIFICATION

SHEET WHERE DETAIL IS DRAWN

ROOM IDENTIFICATION

ROOM NAME

ROOM NO.

KEYED NOTES

PLATE

PROPERTY LINE

PLASTIC LAMINATE

PLYWOOD

DOOR SYMBOL

ROOM ENTERED

DOOR IDENTIFICATION IN ROOM

WINDOW SYMBOL

WINDOW TYPE

WINDOW NUMBER

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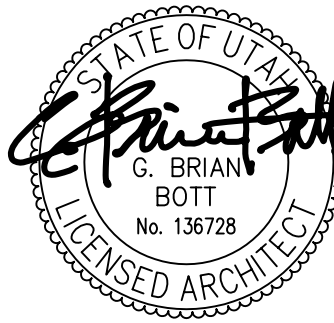
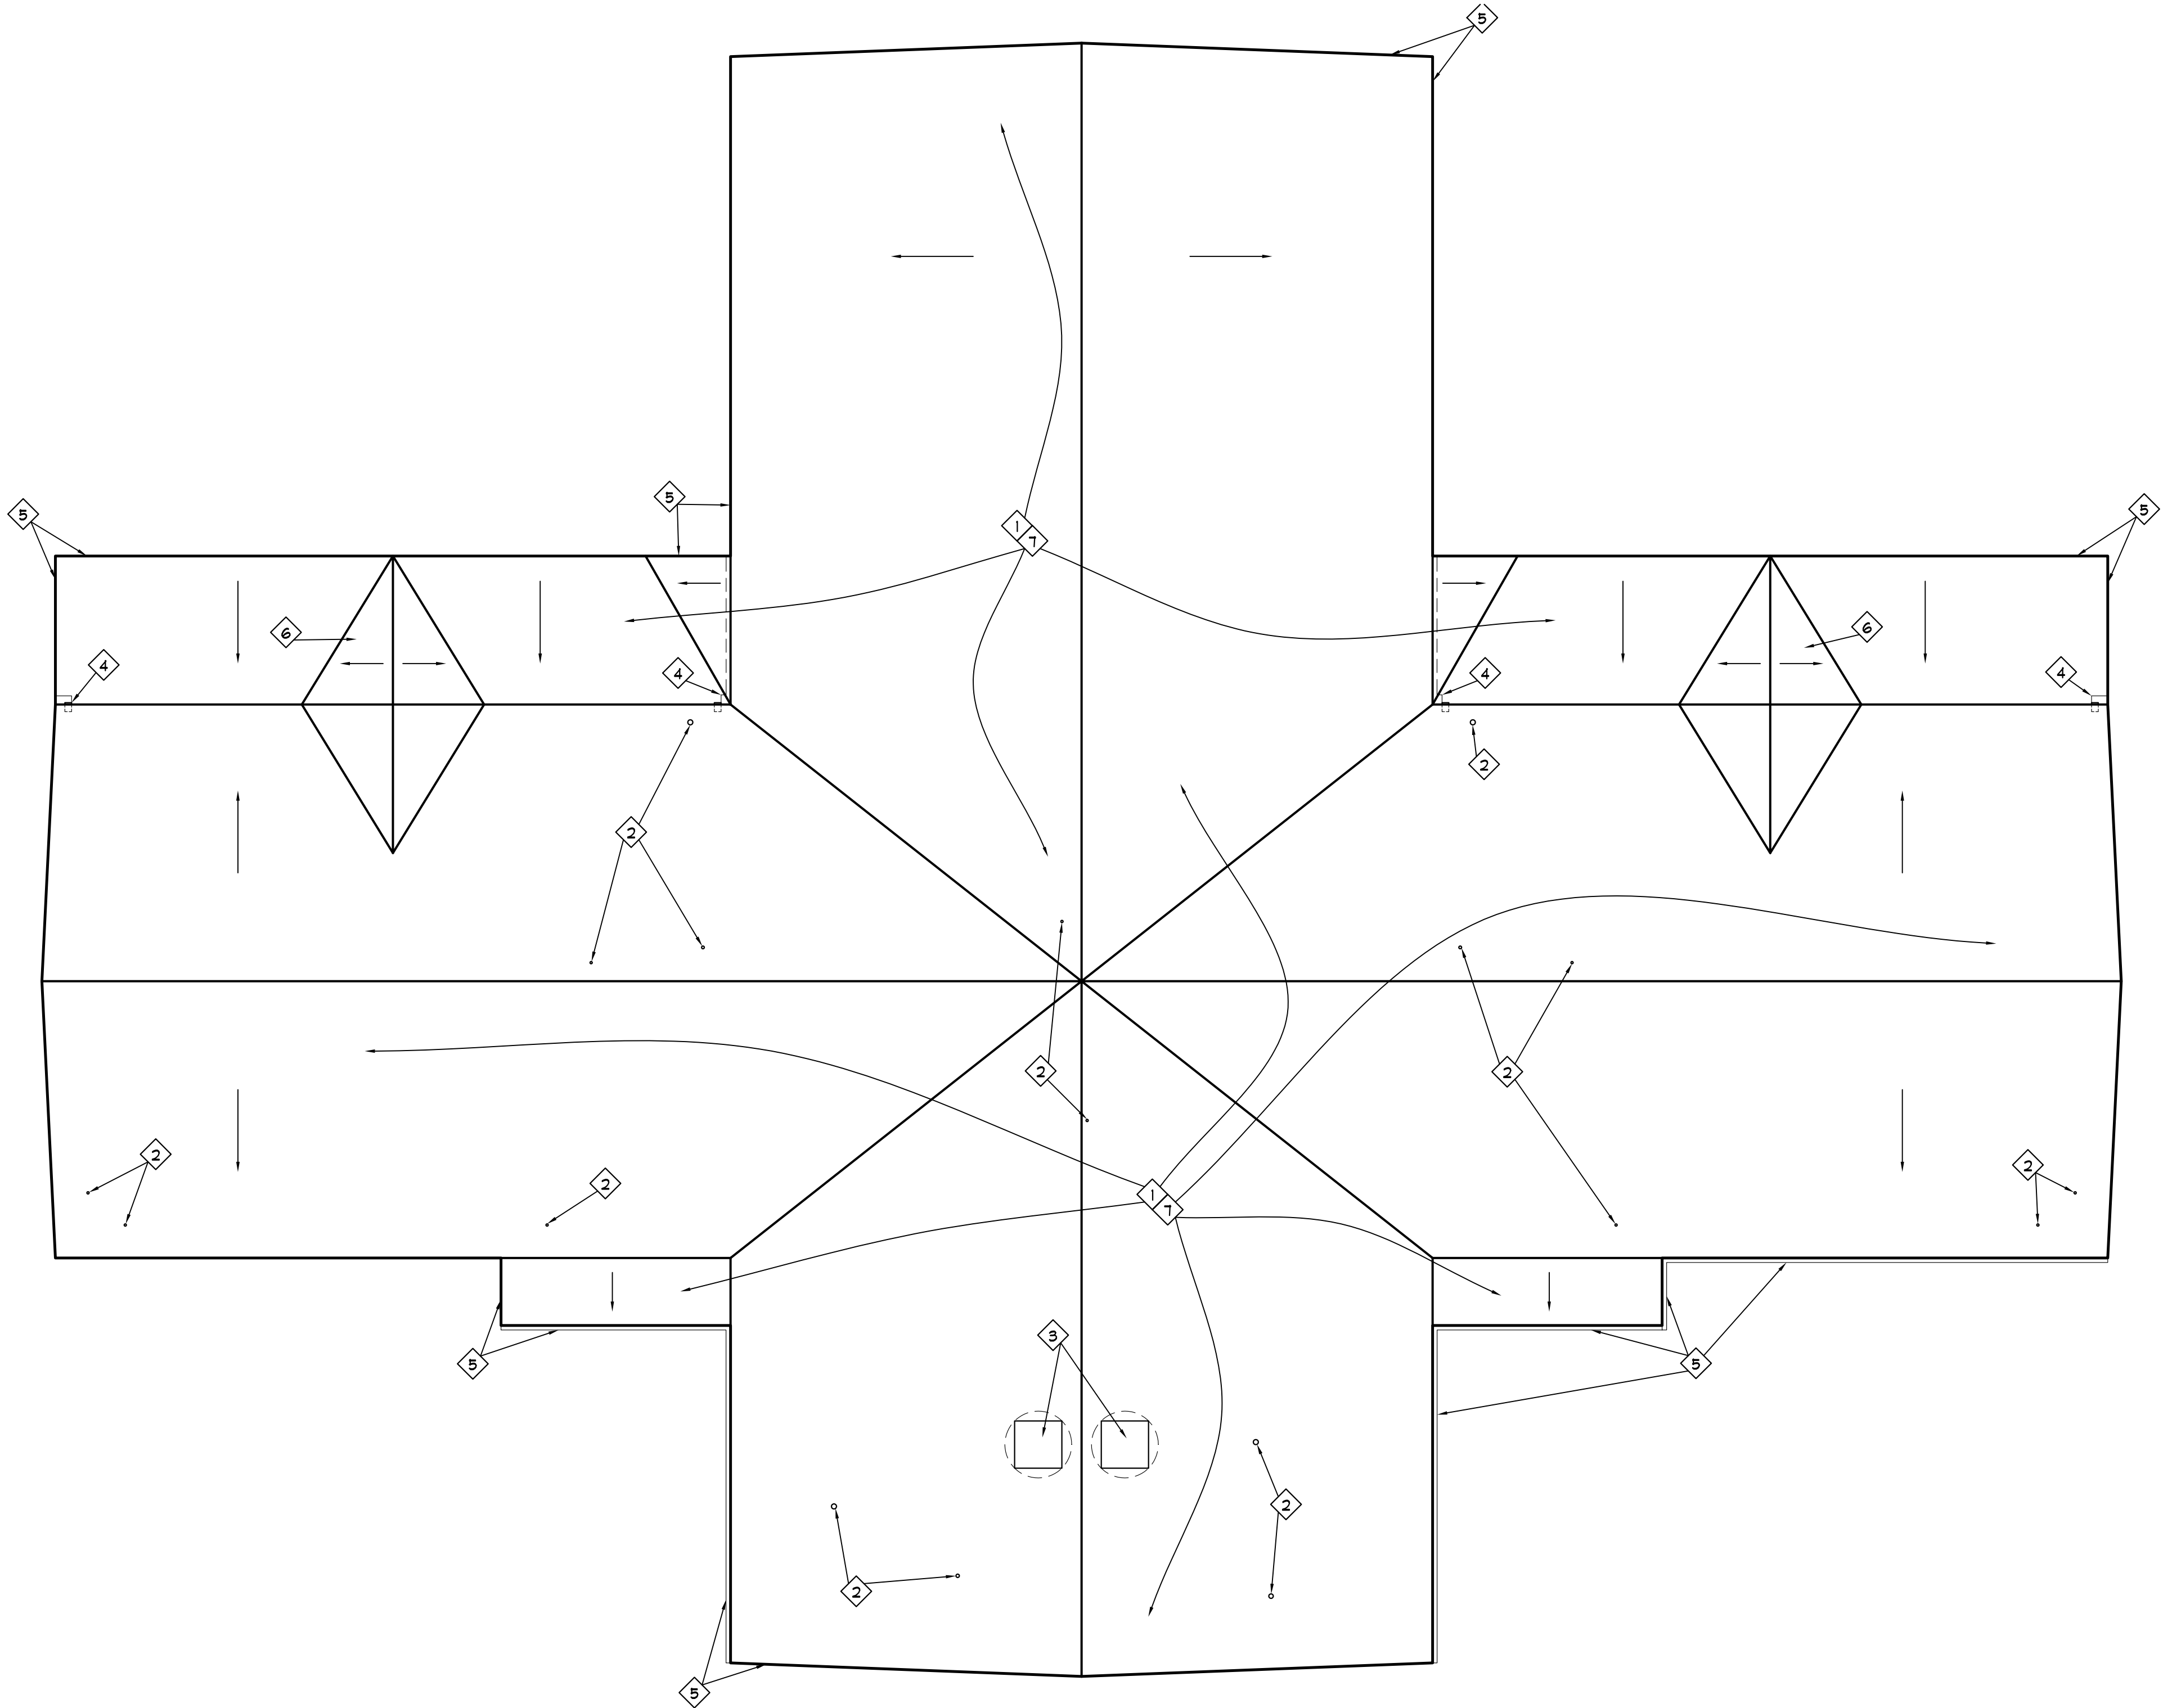
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SITE DEMOLITION GENERAL NOTES

- A. PROVIDE ALL MISCELLANEOUS FLASHING & ACCESSORIES REQUIRED FOR A COMPLETE JOB. FLASH ALL ROOF PENETRATIONS. REMOVE AND REINSTALL ALL MISCELLANEOUS EQUIPMENT.
- B. ALL MISC. VENTS, FLUES, CURBS ETC. TO MEET MIN. CODE CLEARANCE ABOVE NEW ROOF LINE.
- C. FIELD VERIFY EXACT SIZES AND DIMENSIONS.
- D. REMOVE ALL EXISTING B.U.R. VENTS.

SITE DEMOLITION KEYED NOTES

- 1 REMOVE EXISTING B.U.R. ON 2 LAYERS OF 3/4" PERLITE DOWN TO EXISTING T&G DECK. MECHANICALLY FASTEN 1/4" DENS-DECK THEN FULLY ADHERE 2 LAYERS OF 1 1/2" POLYISOCYANURATE INSULATION & SINGLE-PLY, FELT-BACK PVC MEMBRANE TO T&G DECK.
- 2 FLASH EXISTING VTR, SEE 1/A-2.
- 3 MECHANICAL PENTHOUSE, REMOVE AND REINSTALL AS REQUIRED TO FLASH EXISTING CURB, SEE 3/A-2.
- 4 EXISTING ROOF DRAIN TO BE CLEANED FROM ALL DEBRIS. CAP EXISTING DRAIN PIPE IN WALL. PROVIDE NEW 3" GALV. PIPE, RUN TO EDGE OF SIDEWALK. PROVIDE HEAT TAPE IN PIPE UP TO DRAIN WITH TEMPERATURE & MOISTURE SENSITIVE CONTROLLER, CONTACTOR (IF REQUIRED) & PILOT LIGHT.
- 5 REMOVE EXISTING DRIP EDGE & PROVIDE WELDABLE FLASHING DRIP EDGE WITH CONT. GLEAT FASTENED @ 8" O.C. SEE 2/A-2 SIM.
- 6 PROVIDE TAPERED INSULATION CRICKET.
- 7 PROVIDE 15/32" SHEATHING OVER EXISTING T&G DECK W/ 8D NAILS @ B.N. = 6" O.C. AND E.N. = 6" O.C. OVER ENTIRE ROOF. VERIFY NAILS DO NOT PENETRATE ALL THE WAY THROUGH EXISTING T&G DECK.



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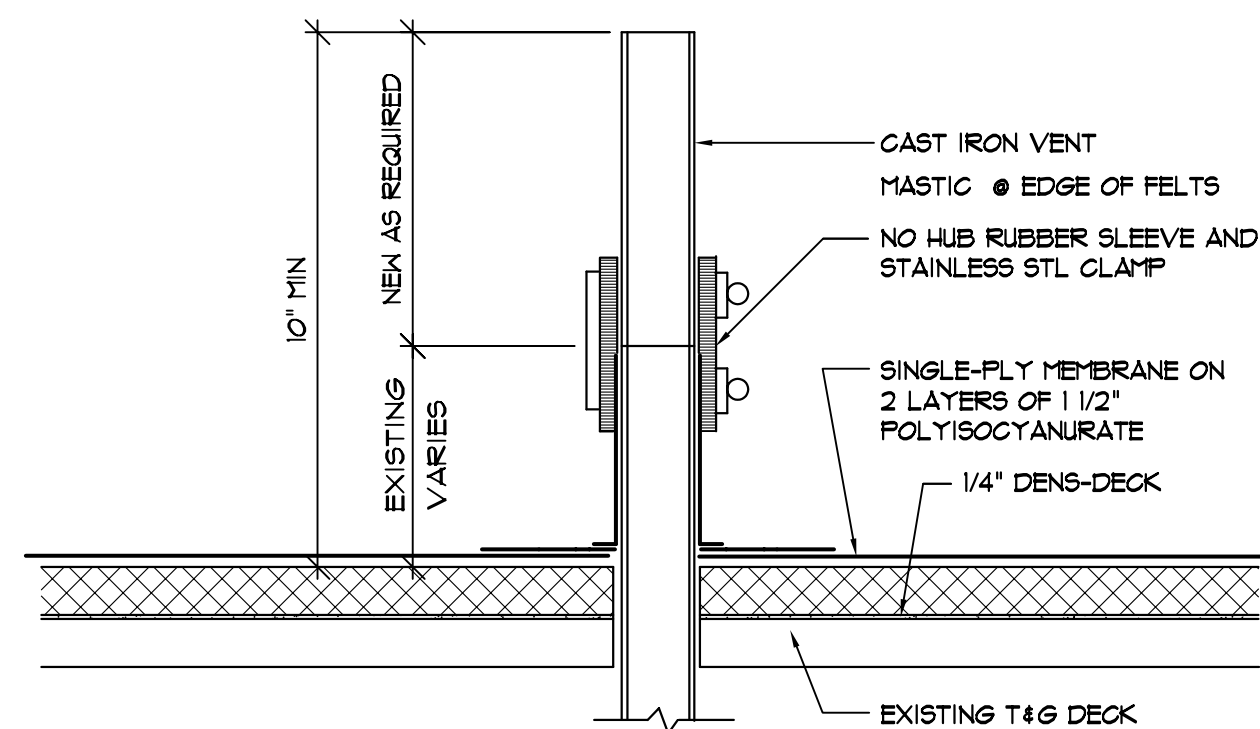
PROJECT NUMBER
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JUNE 7, 2007
DRAWN BY
M. MANZANARES

PROJECT:
OGDEN WEBER ATC
CHILDREN SCHOOL NORTH &
SOUTH BUILDING REROOF


PROJECT ADDRESS:
200 NORTH WASHINGTON BLVD.
OGDEN, UTAH 84404

SHEET TITLE:
ROOF PLAN
CHILDREN SCHOOL
SOUTH


SHEET NO.
A-I



1 VENT EXTENSION DETAIL
A-2 NOT TO SCALE

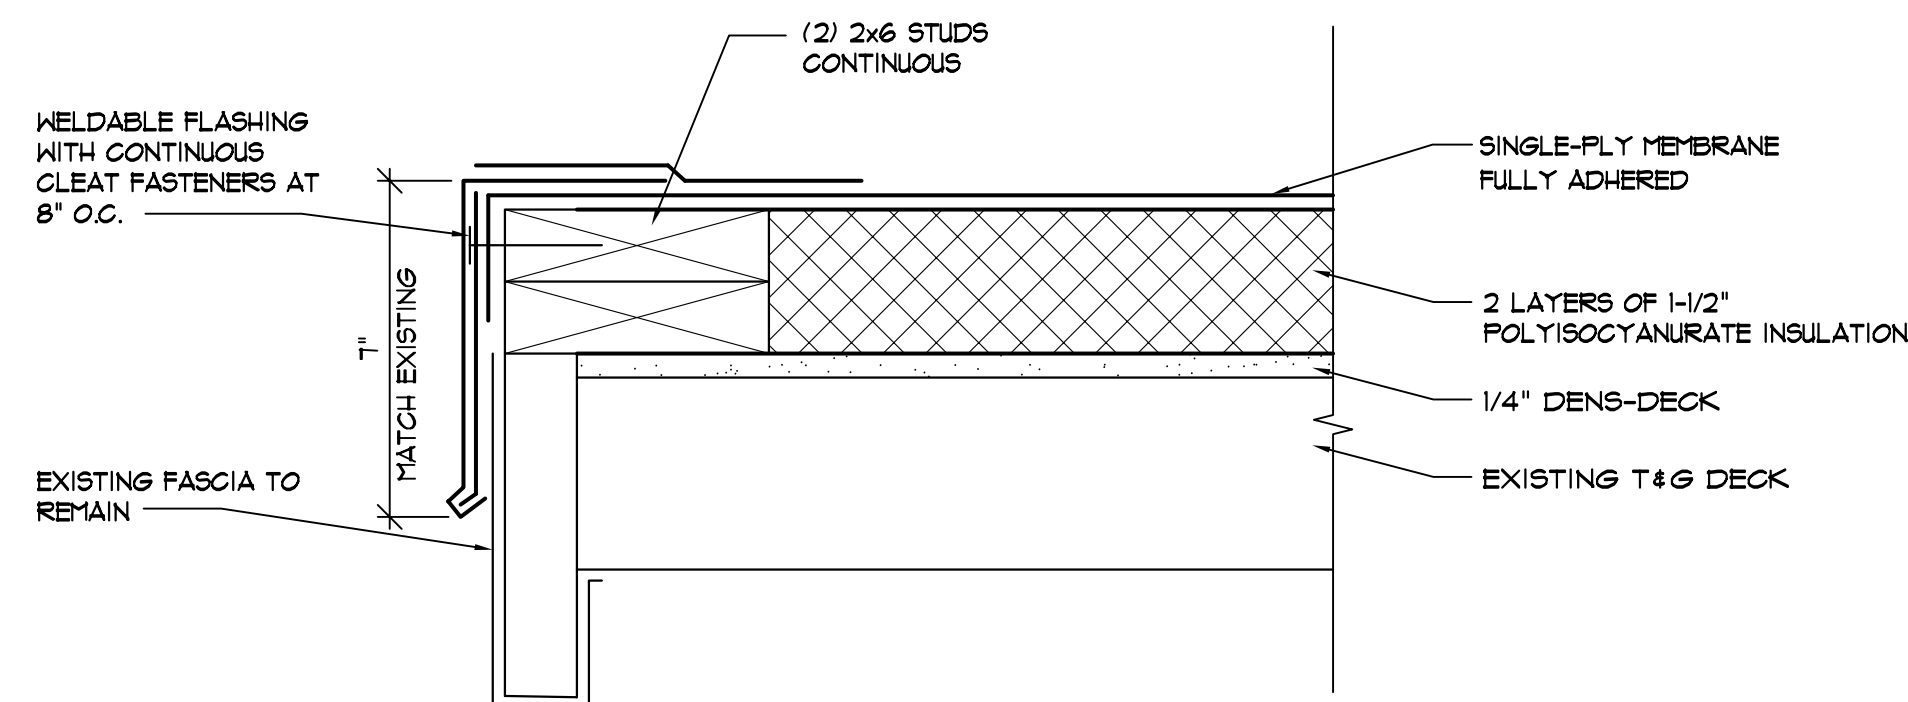

2 FASCIA DETAIL @ CANOPY
A-2 3" = 1'-0"

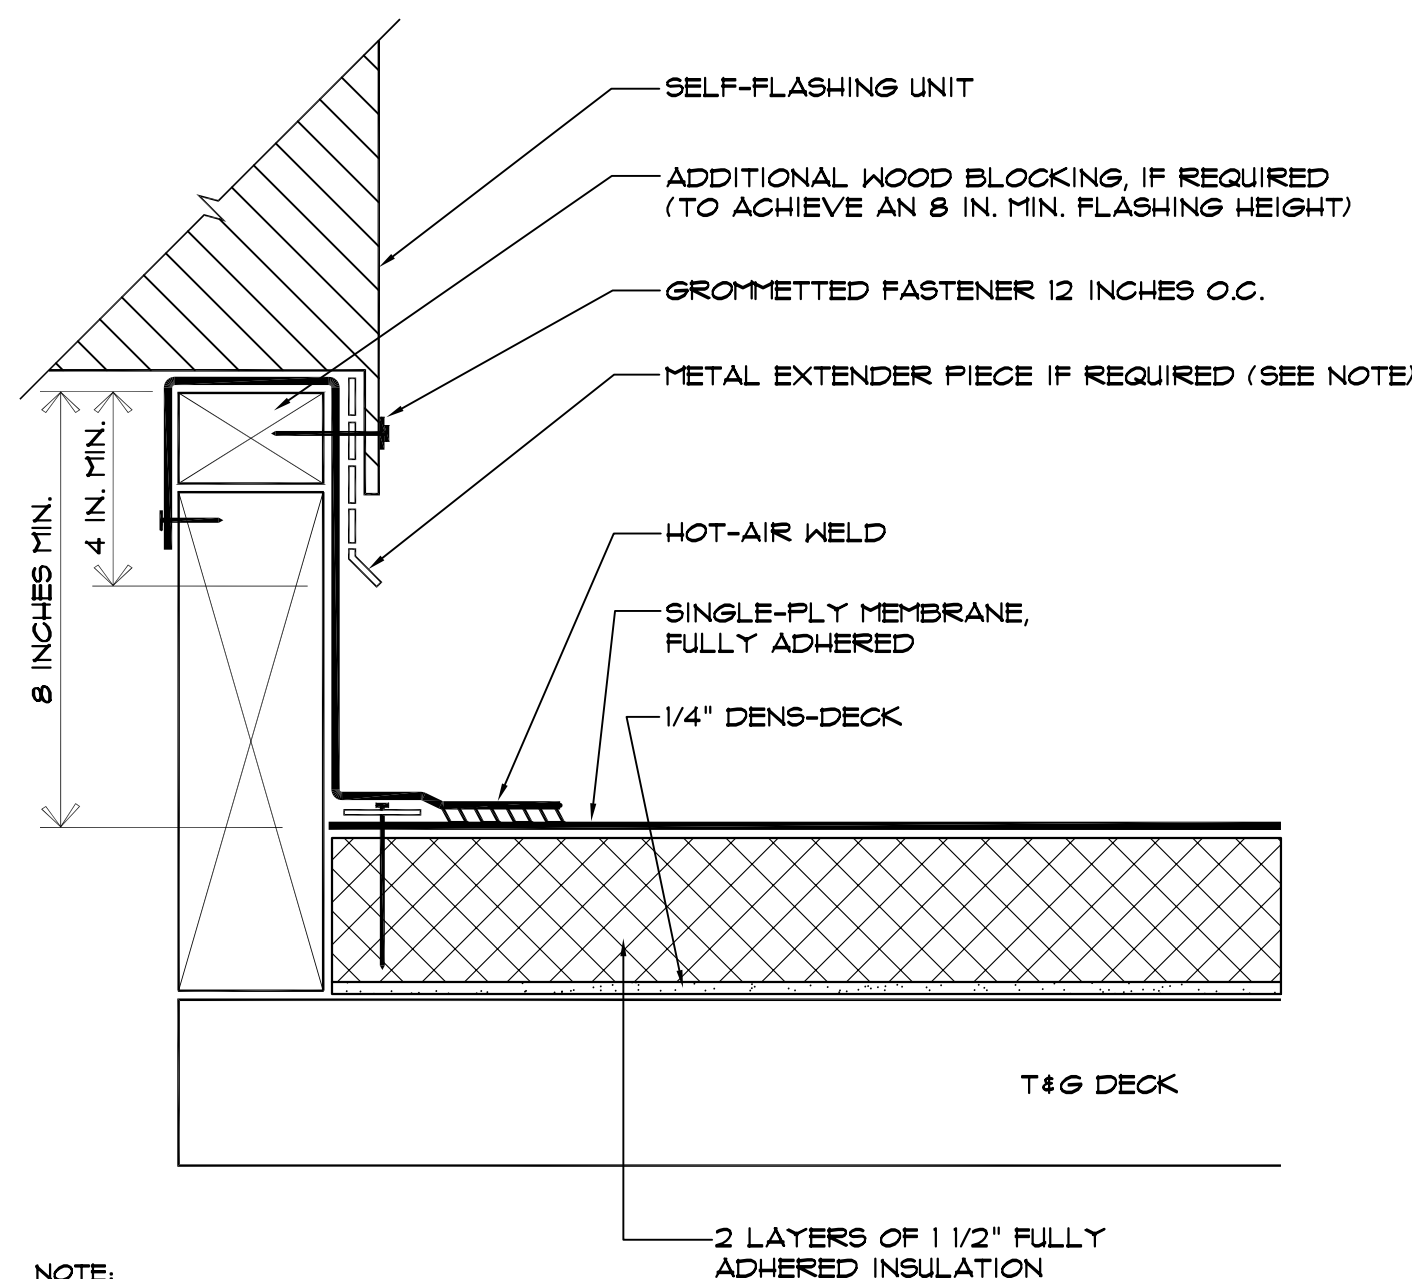

NOTE:
METAL EXTENDER PIECE IS REQUIRED IF EXISTING COUNTERFLASHING IS CONTAMINATED AND/OR COUNTERFLASHING FASCIA IS LESS THAN 4 INCHES WIDE. FASTENED 12 INCHES O.C. WITH GROMMETTED FASTENER.


3 CURB FLASHING
A-2 NOT TO SCALE

SITE DEMOLITION GENERAL NOTES


- PROVIDE ALL MISCELLANEOUS FLASHING & ACCESSORIES REQUIRED FOR A COMPLETE JOB. FLASH ALL ROOF PENETRATIONS, REMOVE AND REINSTALL ALL MISCELLANEOUS EQUIPMENT.
- ALL MISC. VENTS, FLUES, CURBS ETC. TO MEET MIN. CODE CLEARANCE ABOVE NEW ROOF LINE.
- FIELD VERIFY EXACT SIZES AND DIMENSIONS.
- REMOVE ALL EXISTING B.U.R. VENTS.

SITE DEMOLITION KEYED NOTES

- REMOVE EXISTING B.U.R. ON 2" OF RIGID INSULATION DOWN TO EXISTING T&G DECK. MECHANICALLY FASTEN 1/4" DENS-DECK THEN FULLY ADHERE 2 LAYERS OF 1 1/2" POLYISOCYANURATE INSULATION & SINGLE-PLY, FELT-BACK, PVC MEMBRANE TO T&G DECK.
- REMOVE EXISTING B.U.R. DOWN TO EXISTING PLY WOOD DECK. MECHANICALLY FASTEN 1/4" DENS-DECK THEN FULLY ADHERE 2 LAYERS OF 1 1/2" POLYISOCYANURATE INSULATION & SINGLE-PLY, FELT-BACK, PVC MEMBRANE TO PLYWOOD DECK.
- REMOVE EXISTING SINGLE-PLY MEMBRANE DOWN TO EXISTING PLYWOOD DECK. MECHANICALLY FASTEN 1/4" DENS-DECK THEN FULLY ADHERE 2 LAYERS OF 1 1/2" POLYISOCYANURATE INSULATION & SINGLE-PLY, FELT-BACK, PVC MEMBRANE TO PLYWOOD DECK.
- FLASH EXISTING VTR, SEE 1/A-2.
- MECHANICAL PENTHOUSE, REMOVE AND REINSTALL AS REQUIRED TO FLASH EXISTING CURB, SEE 3/A-2.
- REMOVE EXISTING DRIP EDGE & PROVIDE WELDABLE FLASHING DRIP EDGE WITH CONT. CLEAT FASTENED @ 8" O.C., SEE 2/A-2.
- REMOVE & REINSTALL EXISTING GUTTER AS REQUIRED FOR NEW FLASHING.
- FLASH EXISTING ANTENNA, SEE 1/A-2 SIM.
- 4"x4"x1'-0" BLOCKS ATTACHED TO ROOF W/ 4" SPACE BETWEEN BLOCKS & STAGGERED BETWEEN ROWS. WRAP W/ SINGLE-PLY MEMBRANE.

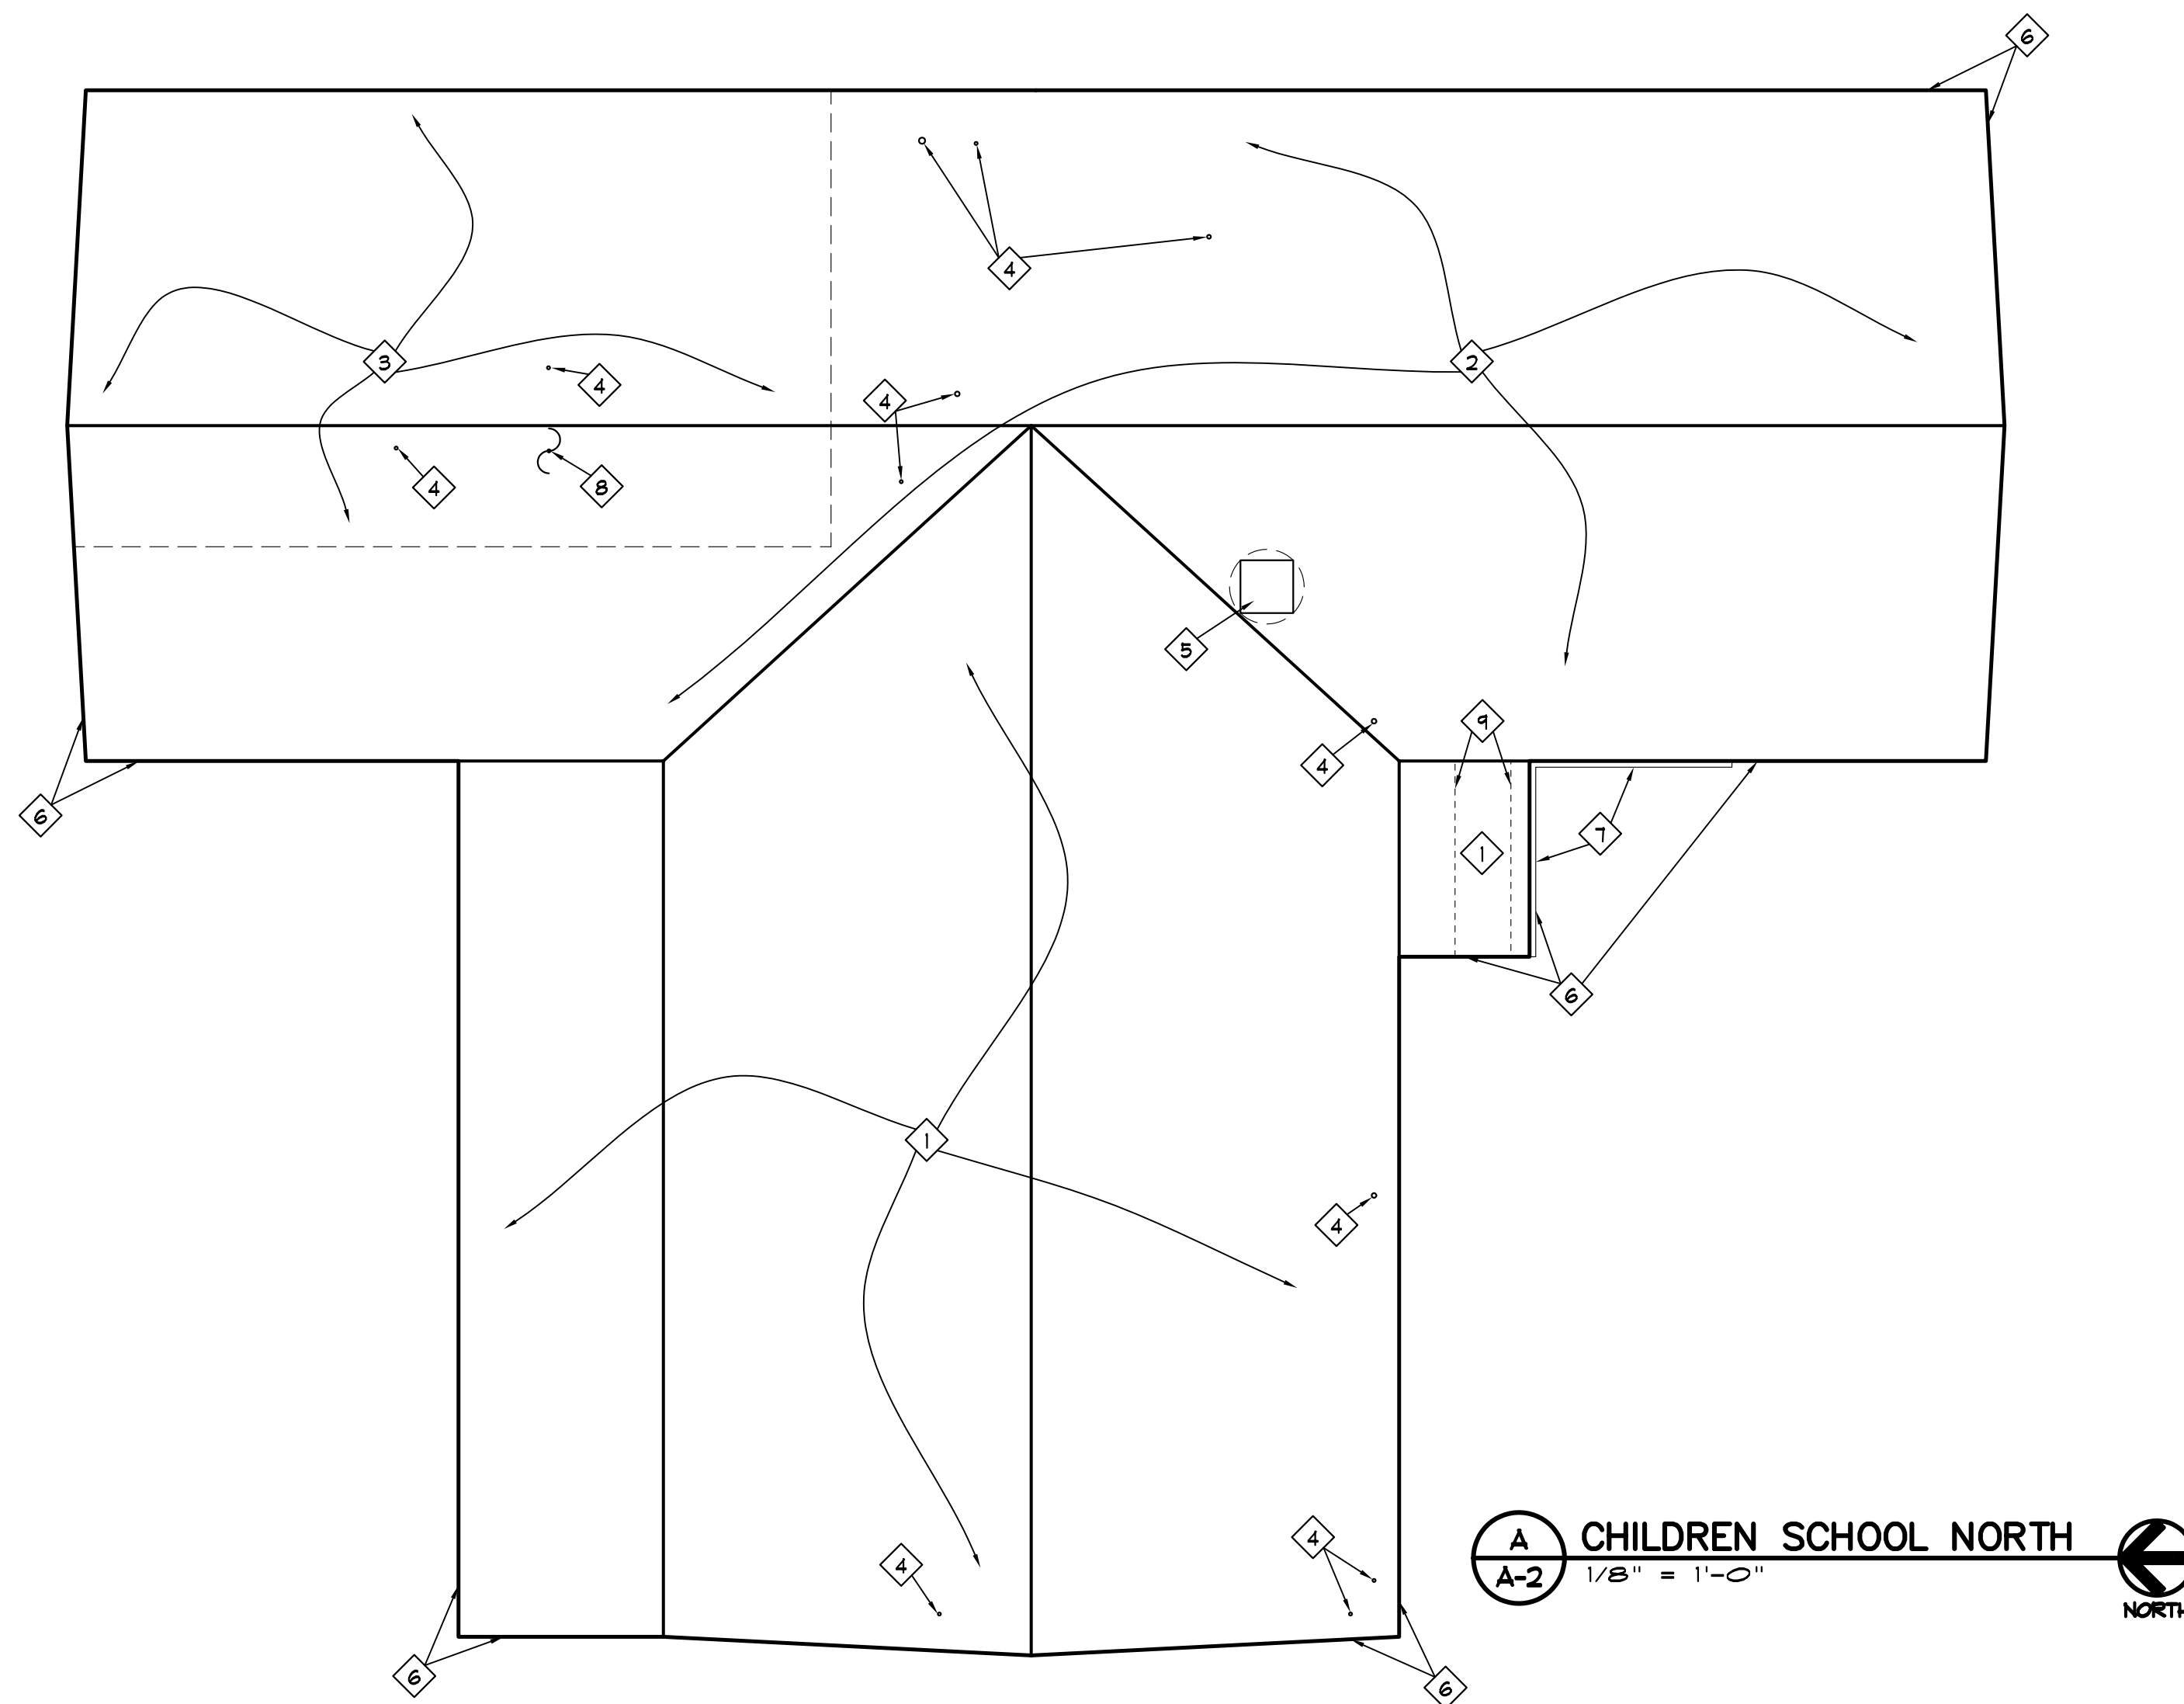

A CHILDREN SCHOOL NORTH
A-2 1/8" = 1'-0"

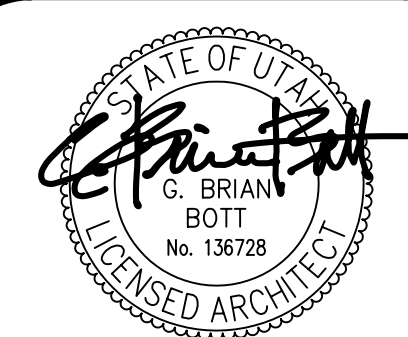

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SHEET TITLE:

ROOF PLAN -
CHILDREN SCHOOL
NORTH & DETAILS

SHEET NO.

A-2